

MIAMI-DADE COUNTY PRODUCT CONTROL SECTION

11805 SW 26 Street, Room 208 Miami, Florida 33175-2474 T (786) 315-2590 F (786) 315-2599

www.miamidade.gov/economy

NOTICE OF ACCEPTANCE (NOA)

KPS Global, LLC 4201 North Beach Street Fort Worth, TX 76137

Scope:

This NOA is being issued under the applicable rules and regulations governing the use of construction materials. The documentation submitted has been reviewed and accepted by Miami-Dade County RER- Product Control Section to be used in Miami Dade County and other areas where allowed by the Authority Having Jurisdiction (AHJ).

This NOA shall not be valid after the expiration date stated below. The Miami-Dade County Product Control Section (In Miami Dade County) and/or the AHJ (in areas other than Miami Dade County) reserve the right to have this product or material tested for quality assurance purposes. If this product or material fails to perform in the accepted manner, the manufacturer will incur the expense of such testing and the AHJ may immediately revoke, modify, or suspend the use of such product or material within their jurisdiction. RER reserves the right to revoke this acceptance, if it is determined by Miami-Dade County Product Control Section that this product or material fails to meet the requirements of the applicable building code.

This product is approved as described herein, and has been designed to comply with the High Velocity Hurricane Zone of the Florida Building Code.

DESCRIPTION: Walk-In Enclosures

APPROVAL DOCUMENT: Drawing No. 06-15, titled "Walk-In Enclosures", sheets 1 through 6 of 6, prepared by Al-Farooq Corporation, dated December 27, 2006, last revision #C dated March 18, 2016, signed and sealed by Javad Ahmad, P.E., on March 24, 2016, bearing the Miami-Dade County Product Control Revision stamp with the Notice of Acceptance number and the expiration date by the Miami-Dade County Product Control Section.

MISSILE IMPACT RATING: Large and Small Missile Impact Resistant

LABELING: Each unit shall bear a permanent label with the manufacturer's name or logo, city, state and the following statement: "Miami-Dade County Product Control Approved", unless otherwise noted herein.

RENEWAL of this NOA shall be considered after a renewal application has been filed and there has been no change in the applicable building code negatively affecting the performance of this product.

TERMINATION of this NOA will occur after the expiration date or if there has been a revision or change in the materials, use, and/or manufacture of the product or process. Misuse of this NOA as an endorsement of any product, for sales, advertising or any other purposes shall automatically terminate this NOA. Failure to comply with any section of this NOA shall be cause for termination and removal of NOA.

ADVERTISEMENT: The NOA number preceded by the words Miami-Dade County, Florida, and followed by the expiration date may be displayed in advertising literature. If any portion of the NOA is displayed, then it shall be done in its entirety.

INSPECTION: A copy of this entire NOA shall be provided to the user by the manufacturer or its distributors and shall be available for inspection at the job site at the request of the Building Official.

This NOA revises & renews NOA # 11-0826.02 and consists of this page 1, evidence submitted pages E-1 & E-2 as well as approval document mentioned above.

The submitted documentation was reviewed by Helmy A. Makar, P.E., M.S.

MIAMI-DADE COUNTY APPROVED He GA. M. M. 06/02/2016

NOA No. 16-0407.08 Expiration Date: 07/26/2022 Approval Date: 06/02/2016

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KPS Global, LLC

NOTICE OF ACCEPTANCE: EVIDENCE SUBMITTED

1. EVIDENCE SUBMITTED UNDER PREVIOUS APPROVAL # 98-0518.03

A. DRAWINGS

1. Drawing No. 06-15, titled "Walk-In Enclosures", sheets 1 through 6 of 6, prepared by Al-Farooq Corporation, dated December 27, 2006, last revision #A dated June 04, 2007, signed and sealed by Humayoun Farooq, P.E.

B. TESTS

- 1. Test report on Uniform Static air Pressure Test, Large Missile Impact Test, and Cyclic Load Test on Galvanized Steel Sheathed Polyurethane Foam Filled Modular Panel Walk-in Coolers / Freezers, prepared by Architectural Testing, Report No. 64873.01-801-18, dated 01/03/2007, signed and sealed by Joseph A. Reed, P.E.
- 2. Test report on Uniform Static air Pressure Test, Large Missile Impact Test, and Cyclic Load Test on Galvanized Steel Sheathed Polyurethane Foam Filled Modular Panel Walk-in Coolers / Freezers, prepared by Architectural Testing, Report No. 64893.01-801-18, dated 01/03/2007, signed and sealed by Joseph A. Reed, P.E.

C. CALCULATIONS

1. Calculation titled "Panel Calculations", dated 02/16/2007, 57 pages, prepared by Al-Farooq Corporation, signed and sealed by Humayoun Farooq, P.E.

D. QUALITY ASSURANCE

1. By Miami-Dade County Building Code Compliance Office.

E. MATERIAL CERTIFICATIONS

- 1. Flame Spread Index and Smoke Developed Index of Polyurethane Foam per ASTM E84-05 by Intertek ETL Semko, Report # 3104693SAT-006, dated February 28, 2007, signed and sealed by Chris Bowness, P.E.
- 2. Standard Test Method for Determining Ignition Properties of Plastics of Polyurethane Foam per ASTM D1929-96 by Intertek ETL Semko, Report # 3104693SAT-002, dated 11/29/2006, signed and sealed by Chris Bowness, P.E.

2. EVIDENCE SUBMITTED UNDER PREVIOUS APPROVAL # 11-0826.02

A. DRAWINGS

1. Drawing No. 06-15, titled "Walk-In Enclosures", sheets 1 through 6 of 6, prepared by Al-Farooq Corporation, dated December 27, 2006, last revision #B dated 12/20/2011, signed and sealed by Javad Ahmad, P.E., on 03/16/2012.

Hormy A. Makar, P.E., M.S.

Product Control Section Supervisor NOA No. 16-0407.08

Expiration Date: 07/26/2022 Approval Date: 06/02/2016

KPS Global, LLC

NOTICE OF ACCEPTANCE: EVIDENCE SUBMITTED


- B. TESTS
 - 1. None.
- C. CALCULATIONS
 - 1. Calculation, dated January 06, 2012, 23 pages, prepared by Al-Farooq Corporation, signed and sealed by Javad Ahmad, P.E., on January 18, 2012.
- D. QUALITY ASSURANCE
 - 1. By Miami-Dade County Department of Permitting, Environment, and Regulatory Affairs (PERA).
- E. MATERIAL CERTIFICATIONS
 - 1. None.
- 3. NEW EVIDENCE SUBMITTED
- A. DRAWINGS
 - 1. Drawing No. 06-15, titled "Walk-In Enclosures", sheets 1 through 6 of 6, prepared by Al-Farooq Corporation, dated December 27, 2006, last revision #C dated March 18, 2016, signed and sealed by Javad Ahmad, P.E., on 03/24/2016.
- B. TESTS
 - 1. None.
- C. CALCULATIONS
 - 1. Calculation, dated February 03, 2016, 24 pages, prepared by Al-Farooq Corporation, signed and sealed by Javad Ahmad, P.E., on March 24, 2016.
- D. **QUALITY ASSURANCE**
 - 1. By Miami-Dade County Department of Regulatory and Economic Resources.
- E. MATERIAL CERTIFICATIONS
 - 1. None.
- F. STATEMENTS
 - 1. Letter of Compliance with the FBC, 2014 Edition, prepared by Al-Farooq Corporation, signed and sealed by Javad Ahmad, P.E., on March 23, 2016.


Helmy A. Makar, P.E., M.S.

Product Control Section Supervisor


NOA No. 16-0407.08 Expiration Date: 07/26/2022

Approval Date: 06/02/2016

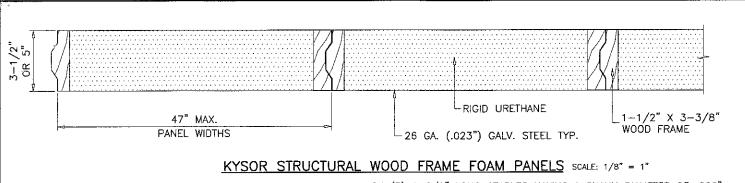


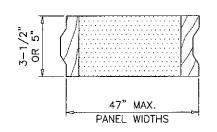

STARTER PANEL

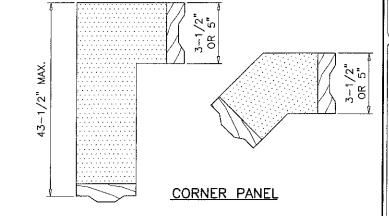

PANEL CORNERS SECURED WITH (3) 1-5/8" LONG STAPLES HAVING A SHANK DIAMETER OF .060". THE EDGE OF SKIN BENT AROUND LATERAL FACE OF WOOD FRAME AND SECURED WITH .060" X 1/2" LONG STAPLES LOCATED AT 1" FROM EACH CORNER AND 7" O.C. MAX.

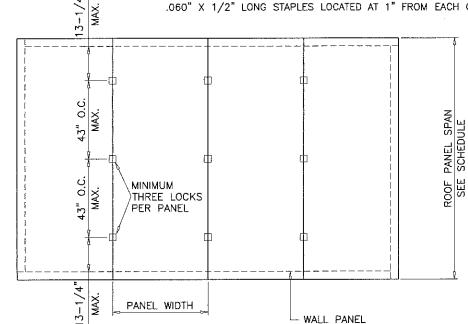

WALL PANELS-SINGLE SPAN △= L/180					
	ALLOWABLE SPAN				
	3-1/2" PANEL	PANEL			
DESIGN WIND LOAD	WITH OR W/O DOOR	WITH DOOR	WITHOUT DOOR		
40 PSF	10'-1"	10'-1"	12'-9"		
50 PSF	9'–9"	9'-9"	12'-8"		
60 PSF	9'-2"	9'-2"	11'-11"		

		11		
ROOF PANELS-SINGLE SPAN △= L/240				
	ALLOWABLE SPAN			
DESIGN WIND LOAD	5" PANEL	1		
70 PSF	11'-8"			

!	SHEET #	INDEX OF DRAWING		
	1 TO 3	SHOWS TYPICAL PANEL/DOOR ELEV. & DETAILS		
	4	SHOWS BEAM AND COLUMN CONNECTION DETAILS		
- WALL PANEL	5 & 6	SHOWS ADDITIONAL DETAILS FOR VARIOUS ENCLOSURE ARRANGEMENTS		

ROOF PLAN OR FLOOR PLAN SCALE: 1/4" = 1'-0"


ROOF PANEL SECTION SPACING 5/16" MAX. 5 THREE LOCKS PER PANEL OUTSWING PANEL WIDTH HINGE 36" MAX. 2 PER DOOR DOOR W. BLDG. LENGTH

FRONT ELEVATION

SCALE: 1/4" = 1'-0"

FLOOR PANEL

(WHEN USED)

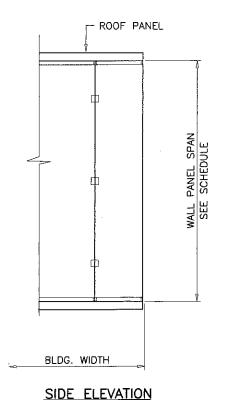

SCALE: 1/4" = 1'-0"


GENERAL NOTES


- 1. THIS PRODUCT HAS BEEN DESIGNED AND TESTED TO COMPLY WITH THE REQUIREMENTS OF THE 2014 (5TH EDITION) FLORIDA BUILDING CODE INCLUDING HIGH VELOCITY HURRICANE ZONE (HVHZ).
- STRUCTURAL STEEL SHALL CONFORM TO ASTM DESIGNATION A-36 AND STEEL SHEET SHALL CONFORM TO ASTM DESIGNATION A-653, GALVANIZED WITH A COATING DESIGNATION OF G90. MIN. Y.S. = 48,380 PSI
- 3. ALL CONCRETE SHALL HAVE A 28 DAY COMPRESSIVE STRENGTH OF 3000 PSI.
- 4. ELECTRICAL AND MECHANICAL DETAILS ARE NOT PART OF THIS APPROVAL.
- 5. POLYURETHANE SHALL BE RIGID FOAM MIN. DENSITY #2 C.F.
- 6. MAX. FLAME SPREAD RATING = 25 OR LESS AS PER ASTM E-84. SMOKE DEVELOPED INDEX = 450 OR LESS AS PER ASTM E-84.

 SPONTANEOUS-IGNITION TEMPERATURE NOT LESS THAN 800°F AS PER ASTM D-1929.
- 7. ALL STEEL TO BE SHOP PRIMED BEFORE ASSEMBLY.
- 8. MATERIALS INCLUDING BUT NOT LIMITED TO STEEL/METAL SCREWS, THAT COME INTO CONTACT WITH OTHER DISSIMILAR MATERIALS SHALL MEET THE REQUIREMENTS OF THE 2014 FLORIDA BUILDING CODE.
- 9. MIN. SOIL BEARING CAPACITY = 2500 PSF.
- 10. A LOAD DURATION INCREASE IS USED IN DESIGN OF ANCHORS INTO WOOD ONLY.

NOTE: ENCLOSURES LARGER THAN 400 SQ. FT. IN AREA SHALL BE EQUIPED WITH AN APPROPRIATE FIRE SUPRESSION SYSTEM, IN ACCORDANCE WITH ALL APPLICABLE CODES AND STANDARDS.

NOTE: THE MAX, LENGTH OF BUILDING SHOULD NOT EXCEED FOUR TIMES THE WIDTH OF THE BUILDING. FOR BUILDING LENGTHS GREATER THAN TWO TIMES WIDTH INTERIOR DIAPHRAGM WALL WILL BE PROVIDED.

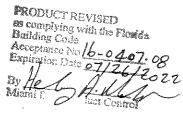

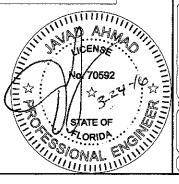

AL-FAROOQ CORPORATION
ENGINEERS & PRODUCT DEVELOPMENT
9360 SUNSET DRIVE, SUITE 220
MIAMI, FLORIDA 33173 (C.A.N. 3538)
TEL (305) 264.8100 FAX CARES CONTROL

TEL (305) 264.8100 (C.A.N. 3538) FAX. (305) 262-6978 COOLER\06 281 (817)

S Global, LLC.

O1 North Beach Street


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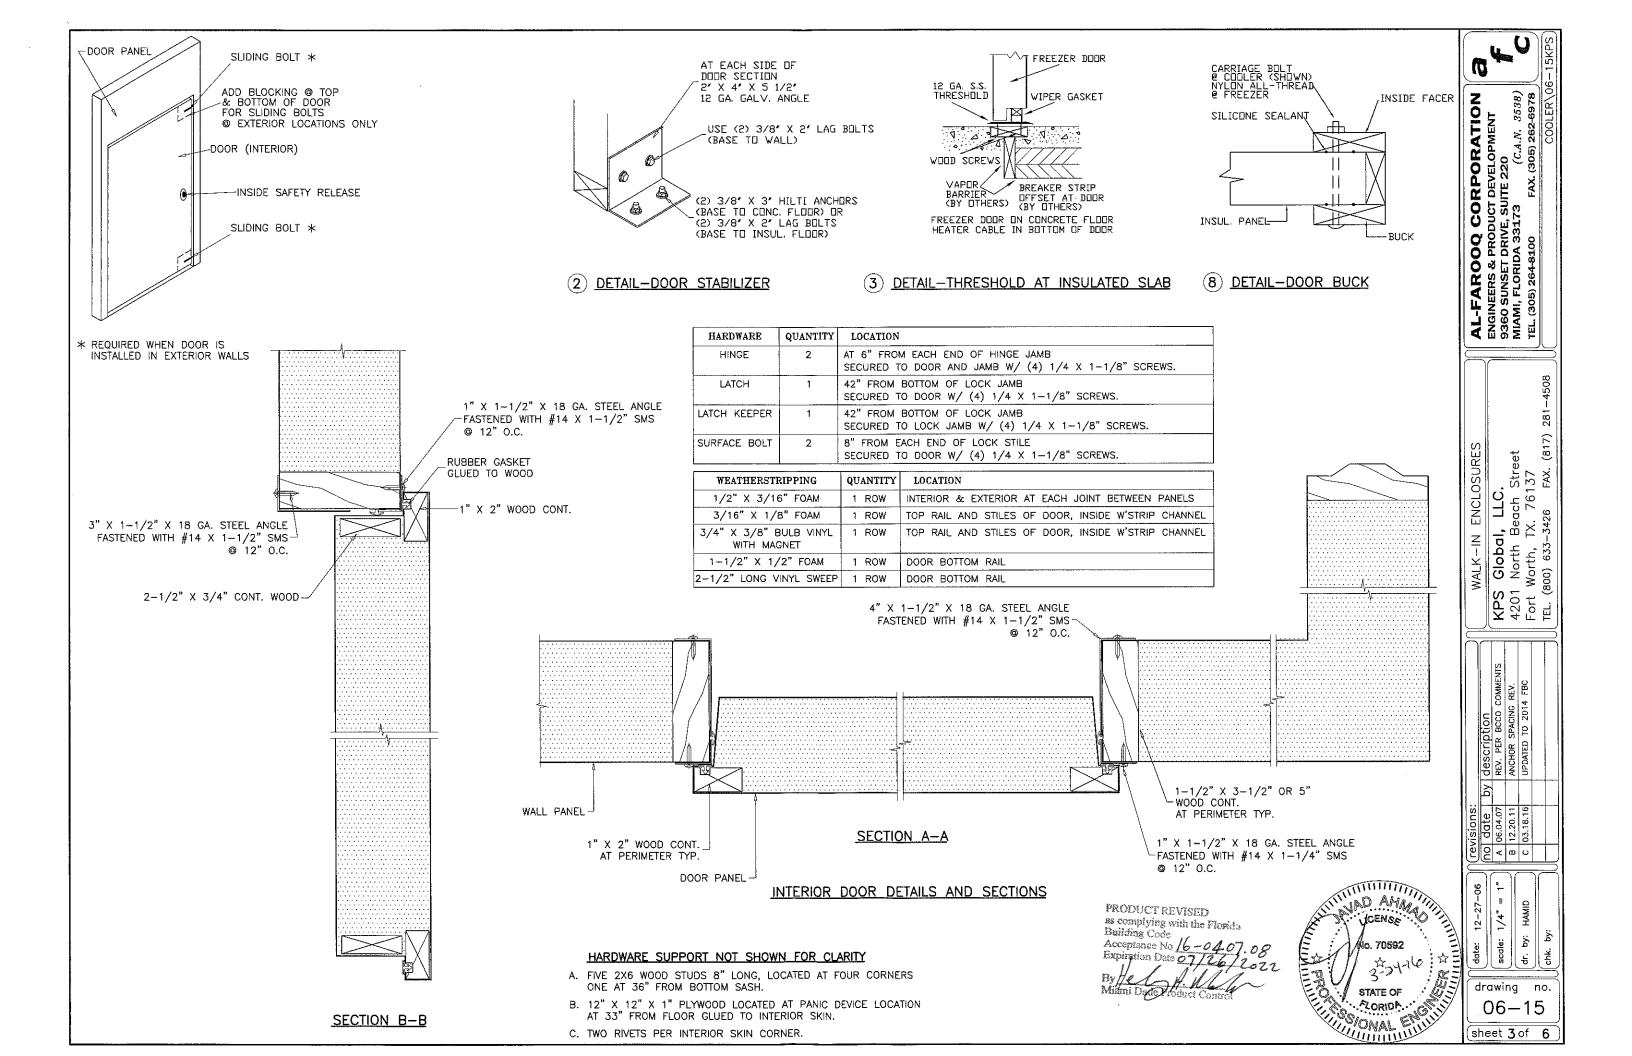
. (800) 633–3426 FAX. (817 WALK-IN ENCLOSURE **KPS** 4201 Fort V TEL. (80 description
REV. PER BCCO COMMENTS
UPDATED TO 2010 FBC
UPDATED TO 2014 FBC


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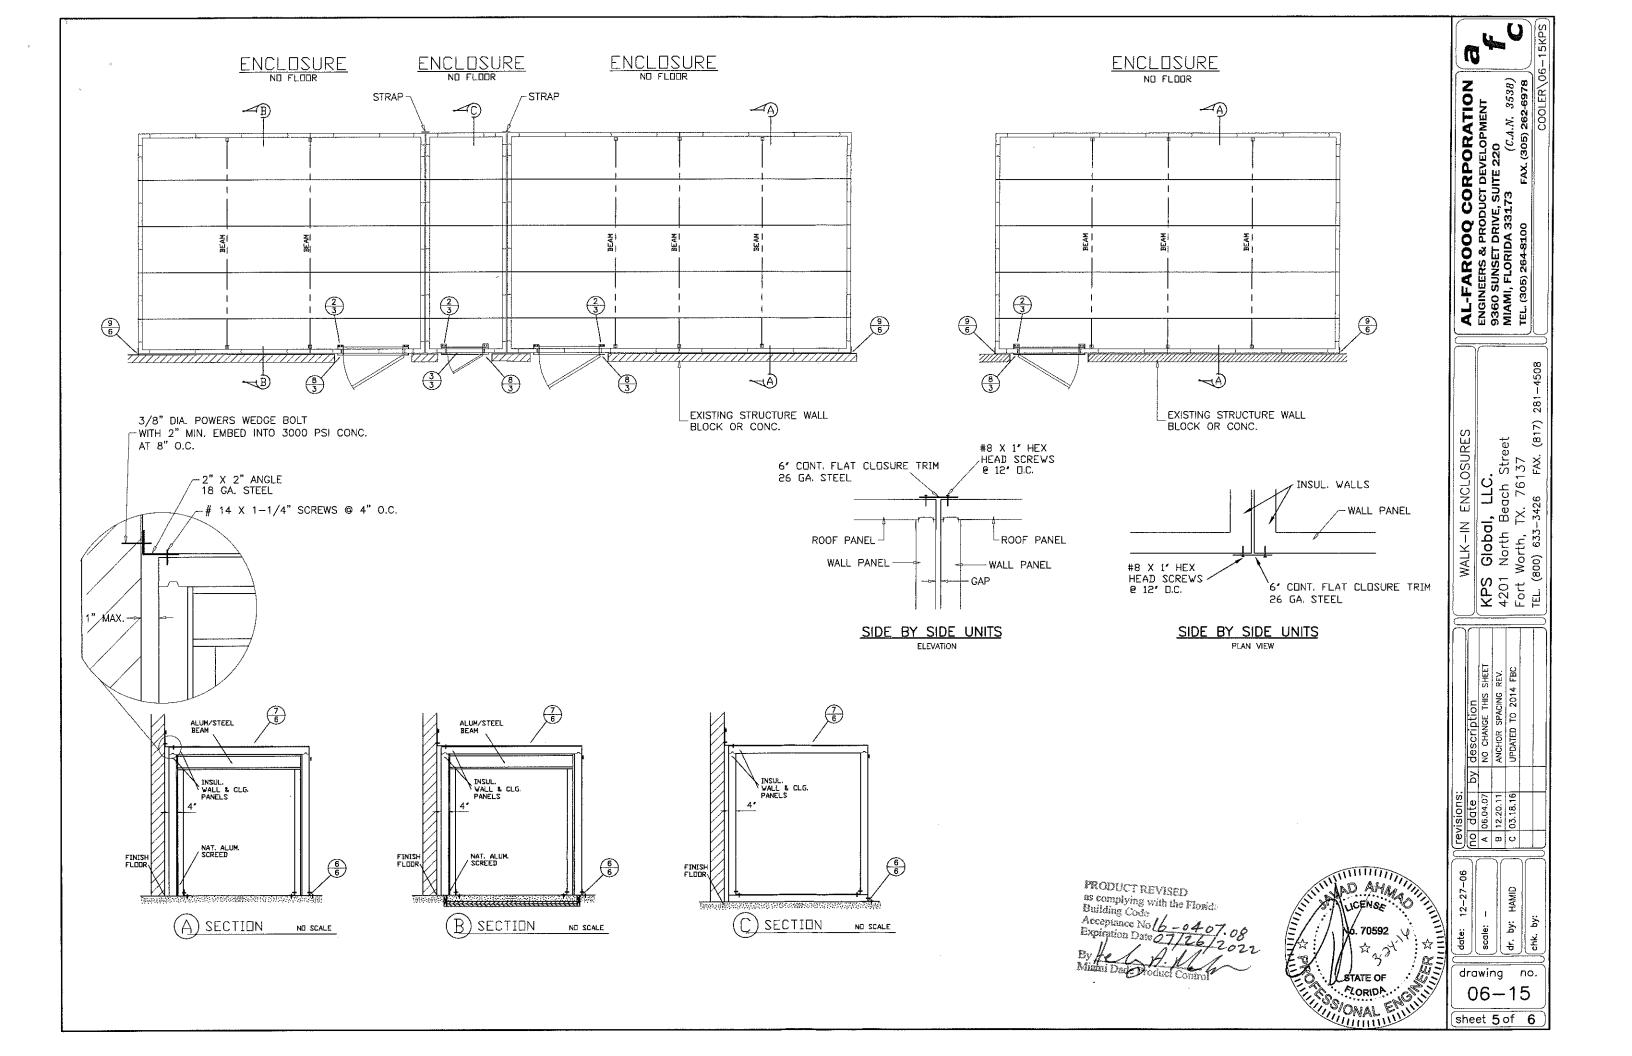
drawing no. 06 - 15

sheet 1 of 6






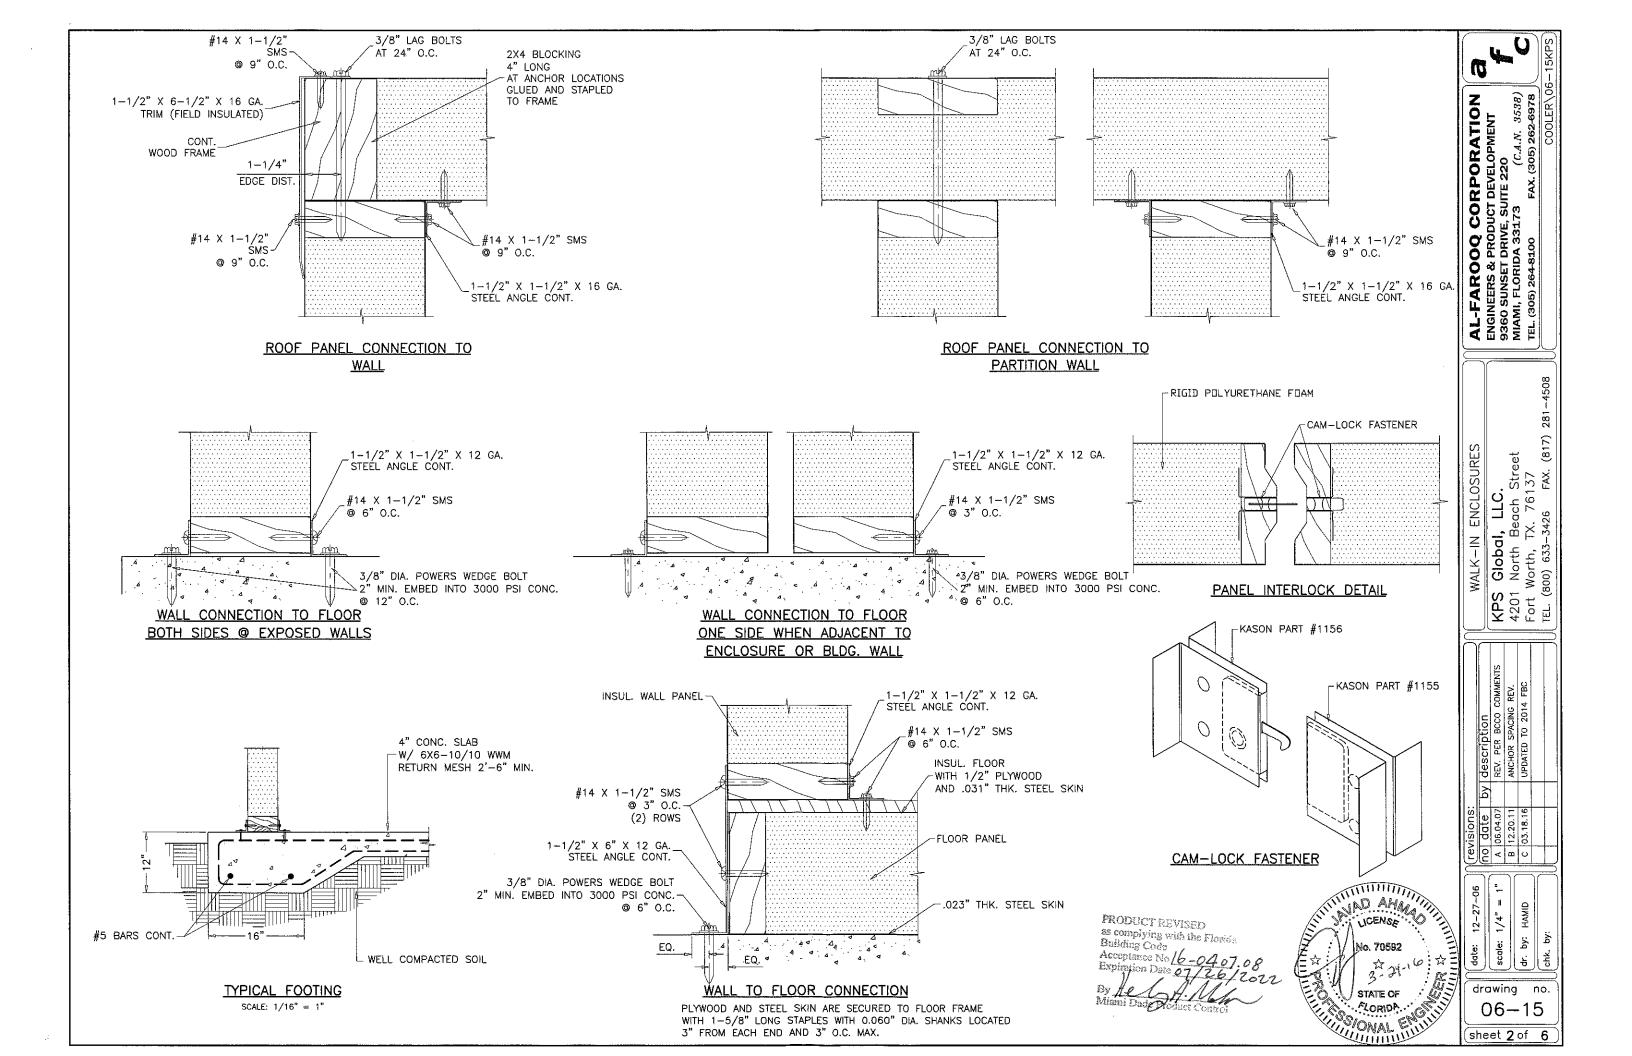

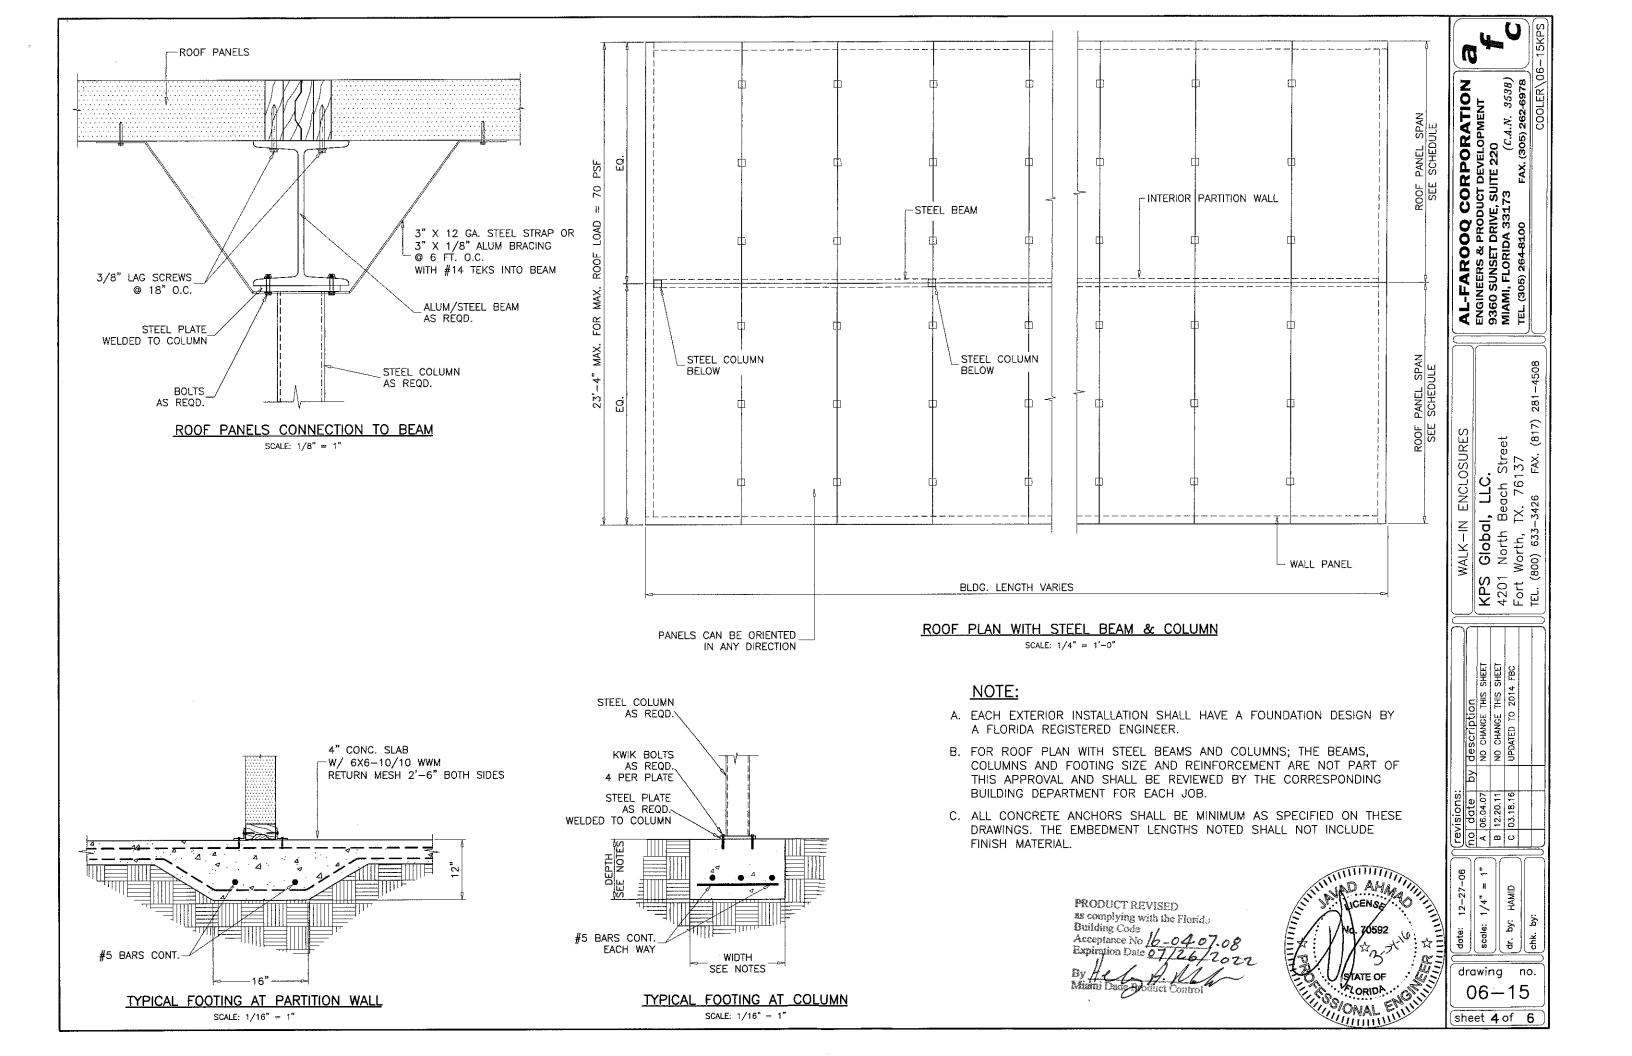


ANCHORS EDGE DISTANCE = 2-1/2" MIN. TYP.

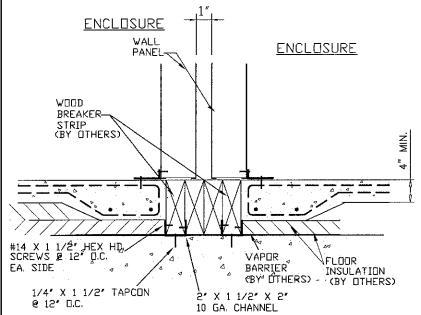


DETAIL-SECTION BETWEEN ENCLOSURES WITH INSULATED SLABS

EXTERIOR UNITS

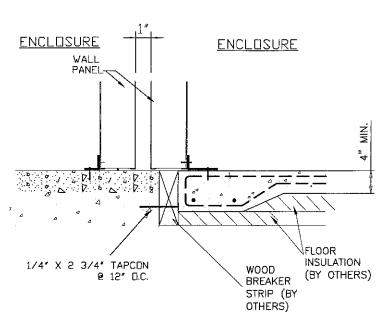

DETAIL-SECTION BETWEEN ENCLOSURE ONE WITH INSULATED SLAB EXTERIOR UNITS

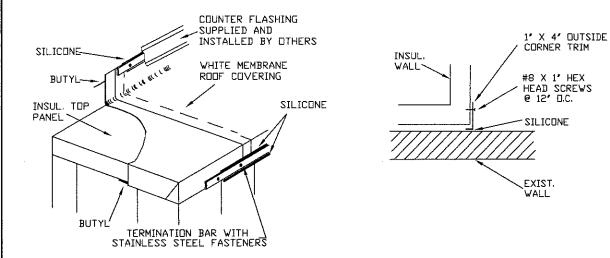


DETAIL-MEMBRANE ROOF

WATER PROOFING NOT PART OF APPROVAL

WATER PROOFING CORNER DETAIL PLAN VIEW

INSULATED SLAB/WOOD SEPARATION AND THEIR CONNECTION TO SLAB SHOWN AS CONSTRUCTION DETAIL ARE NOT PART OF APPROVAL,

> PRODUCT REVISED
> as complying with the Florida
> Building Code Acceptance No 16

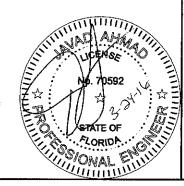

		by description	NO CHANGE THIS SHEET	NO CHANGE THIS SHEET	UPDATED TO 2014 FBC		
	revisions:	no date	A 06.04.07	B 12.20.11	C 03.18.16		
	-27-06 M	7			AMID		
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7	d	ra	wii	na		no	<u> </u>

06 - 15

sheet 6 of 6

 AL-FAROOQ CORPORATION

 ENGINEERS & PRODUCT DEVELOPMENT

 9360 SUNSET DRIVE, SUITE 220

 MIAMI, FLORIDA 33173
 (C.A.N. 3538)

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WALK-IN ENCLOSURES